




FRONT ELEVATION
SCALE : 1 : 10

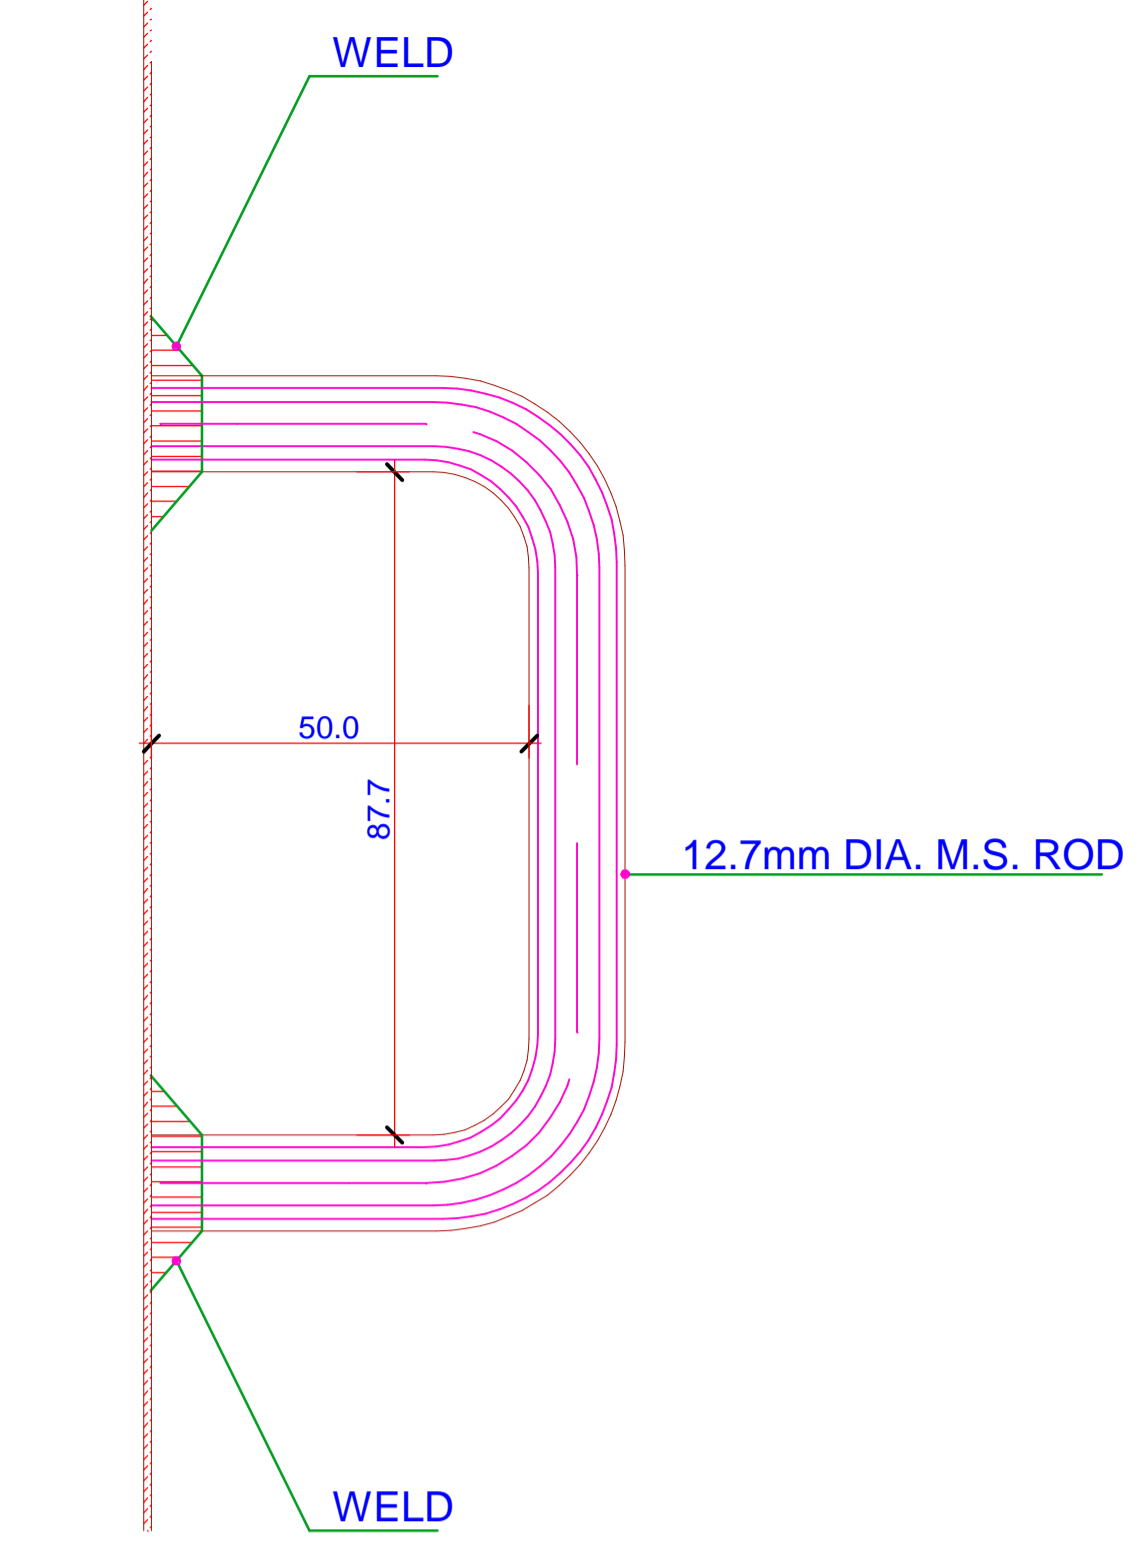


DETAIL 6. OF HANDLE
(ONE FOR EACH DOOR)
SCALE : 1 : 1

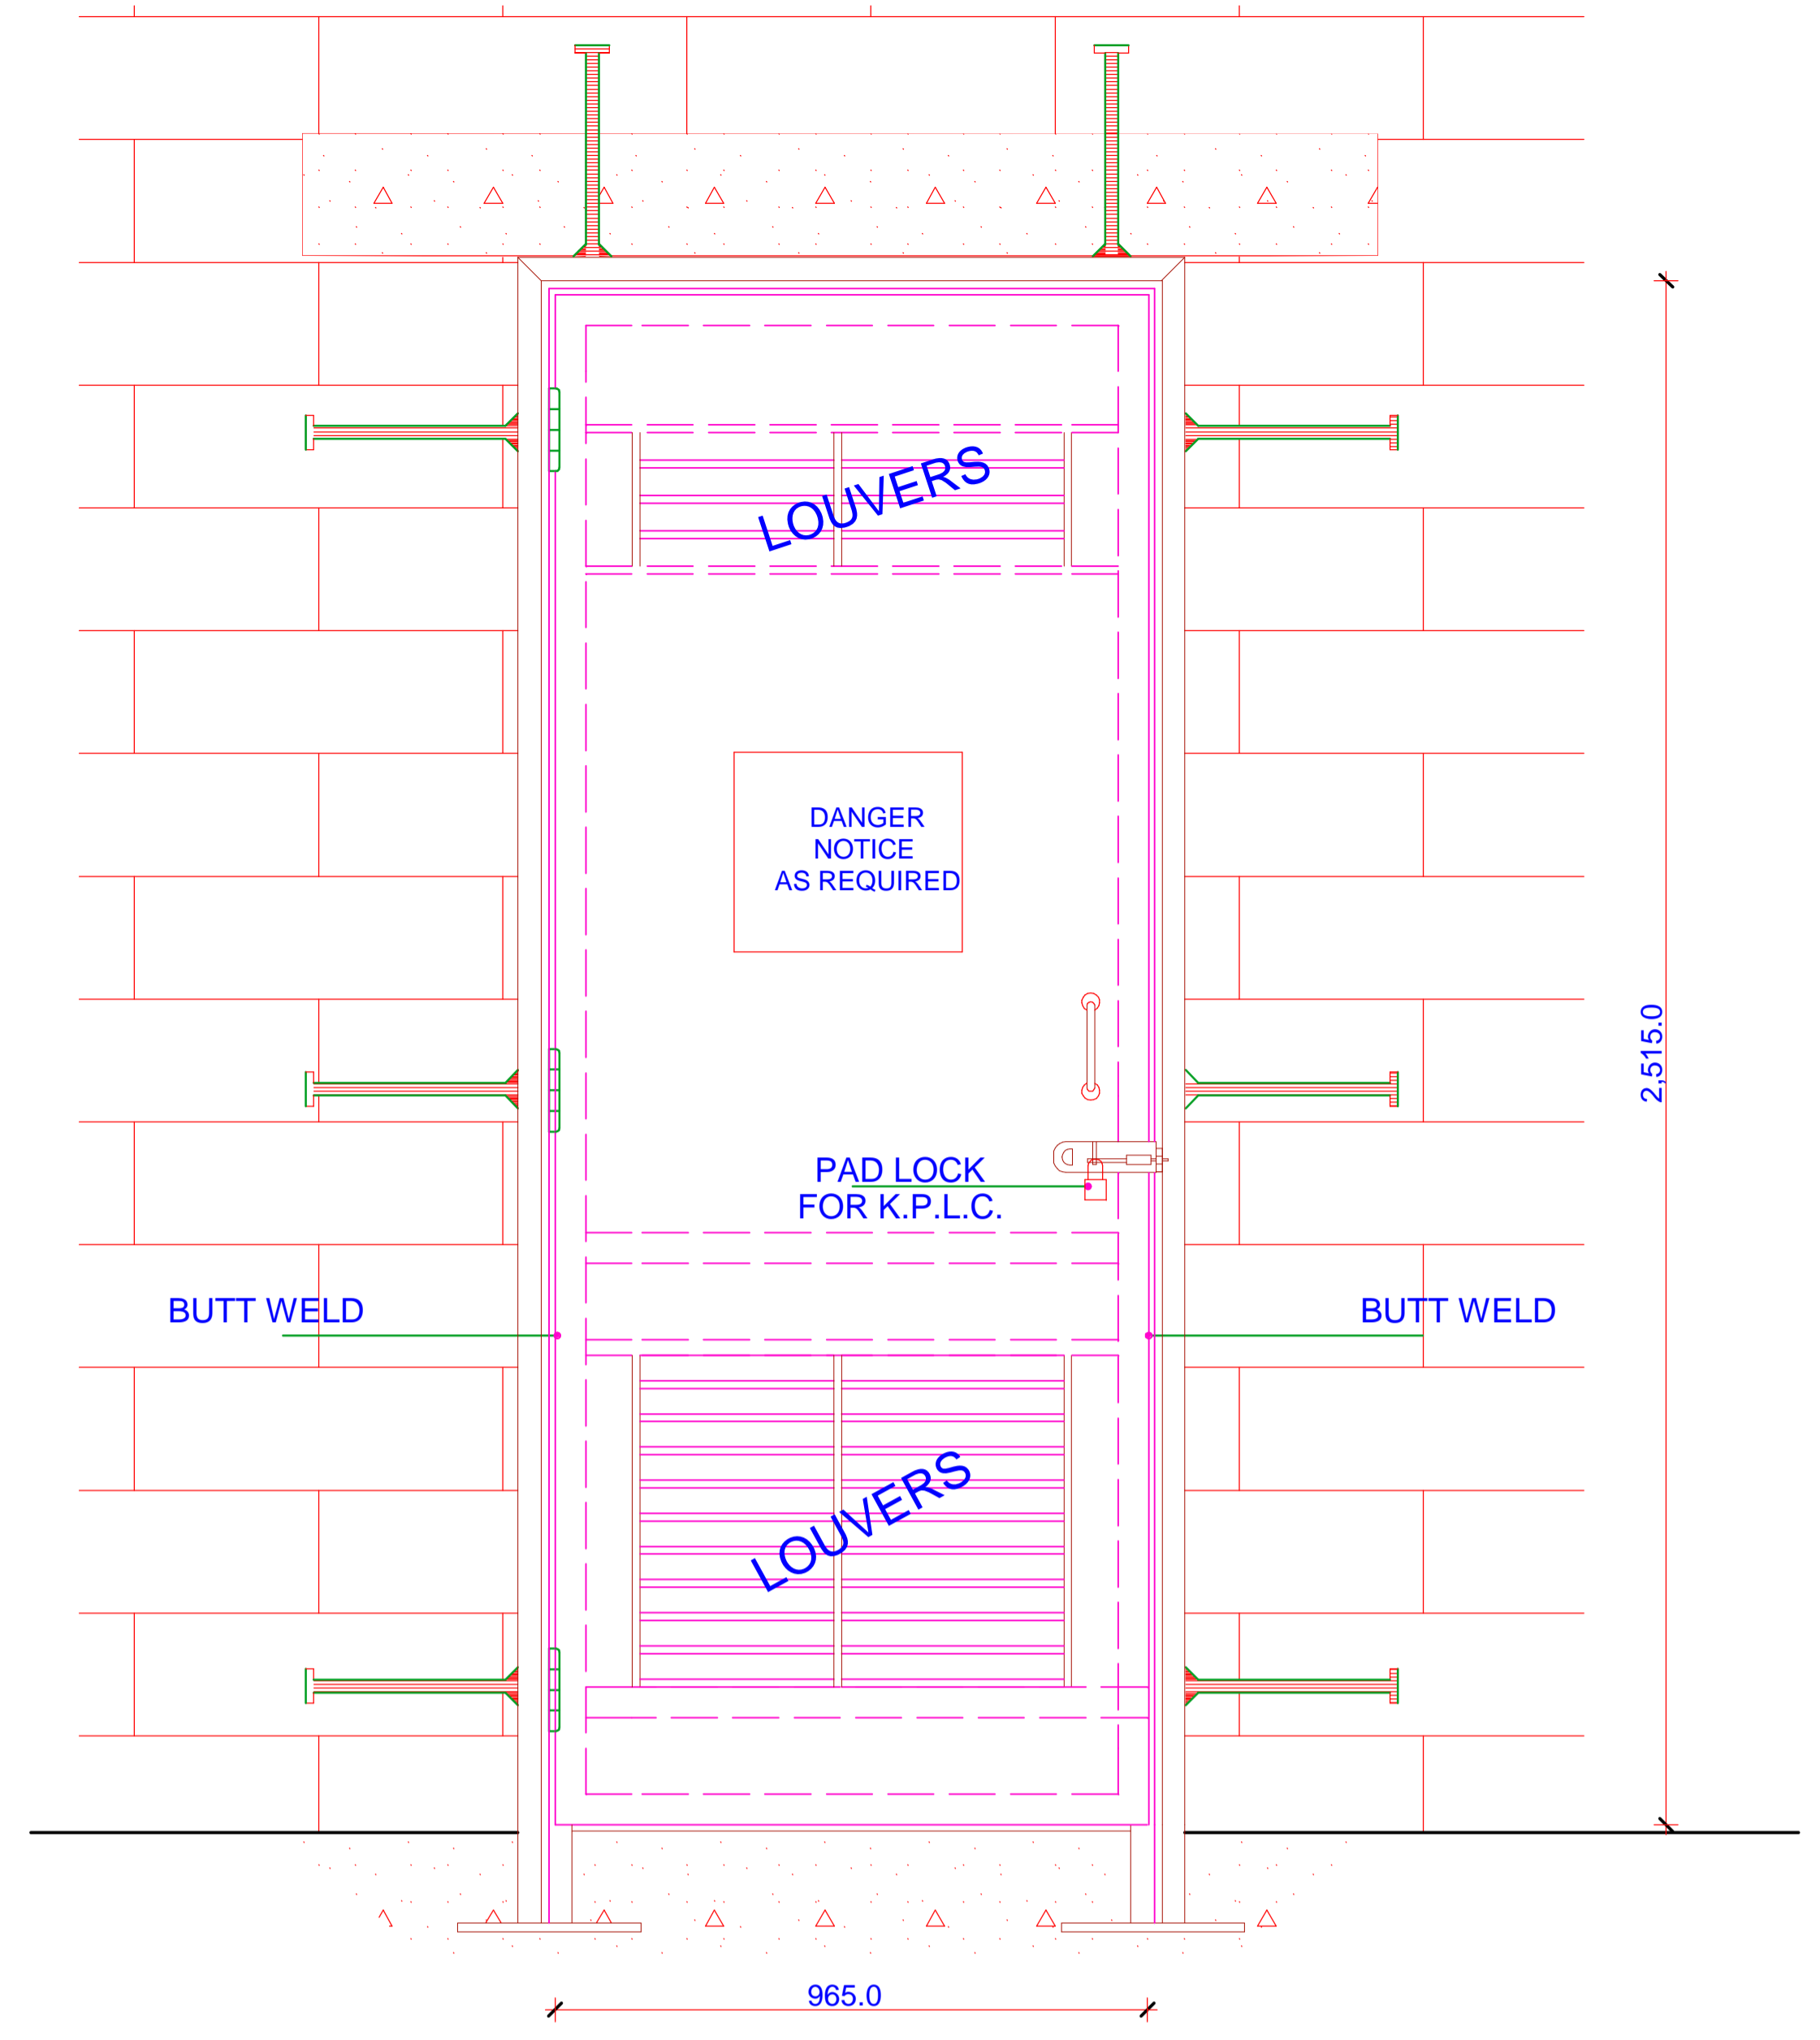


FRONT ELEVATION (EMERGENCY DOOR)
SCALE : 1 : 10

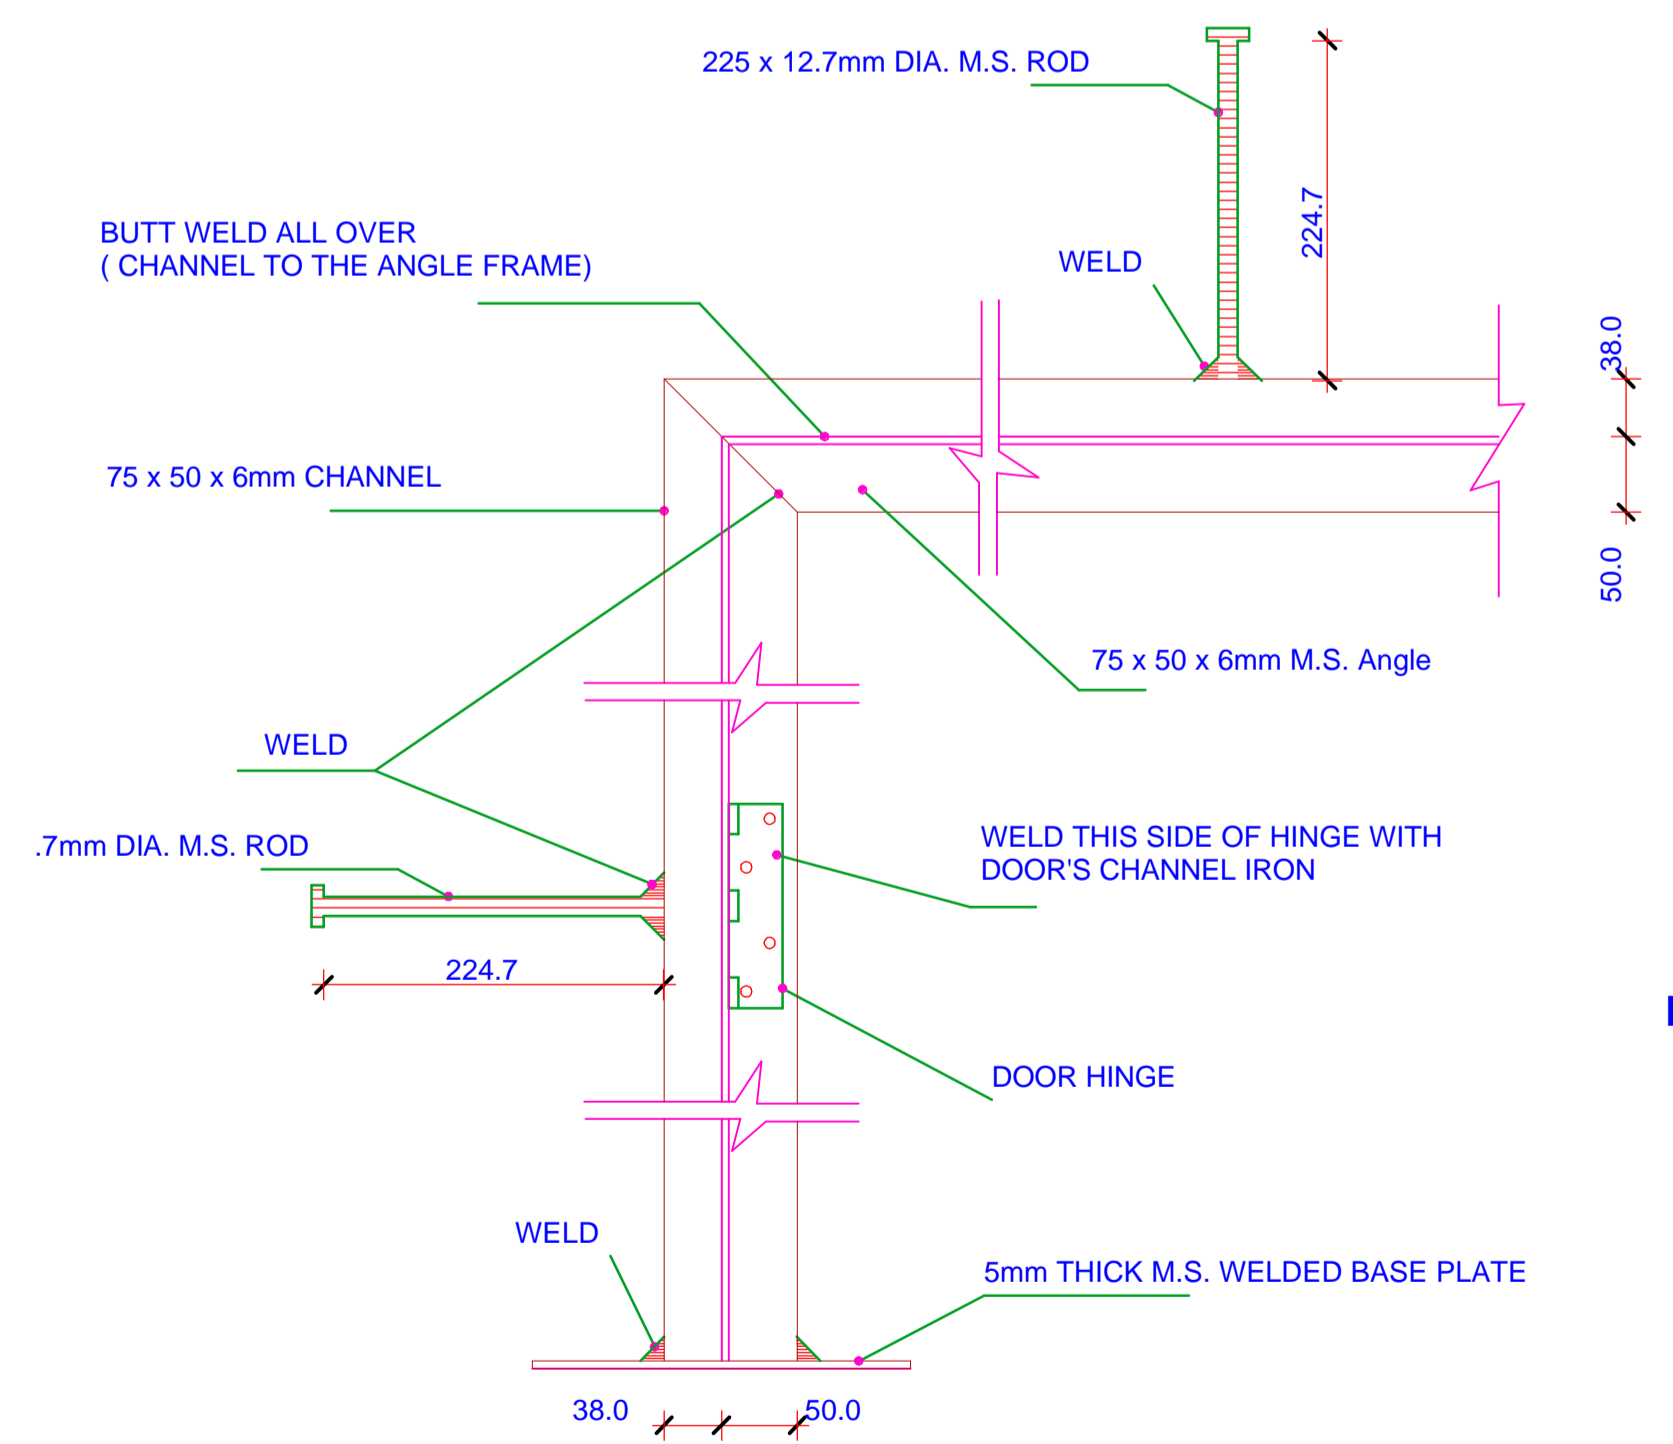


DETAIL 1 & 9 OUTER DOOR FRAM
SCALE : 1 : 5

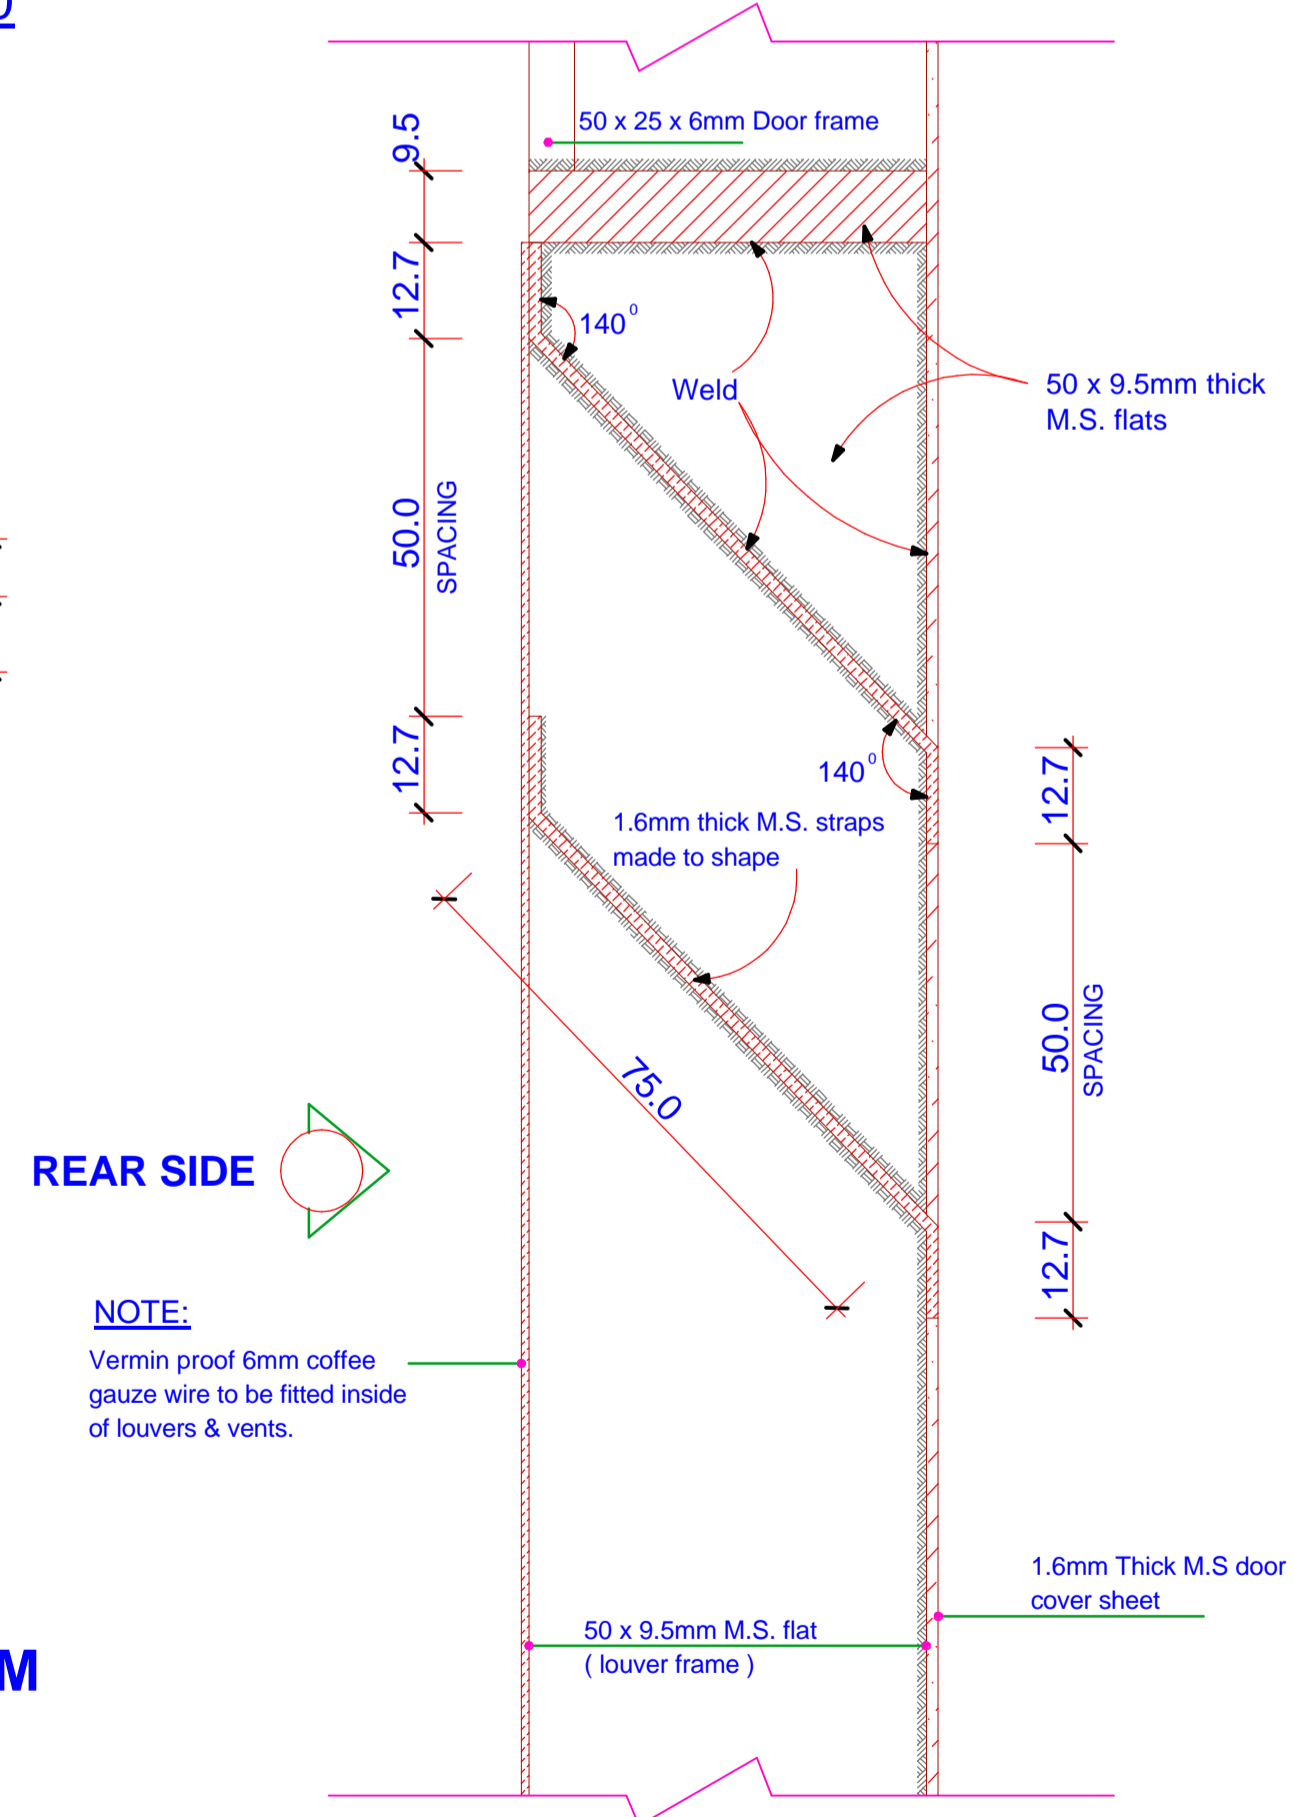


DETAIL 7 SECTIONAL VIEW OF LOUVERS
SCALE : 1 : 1

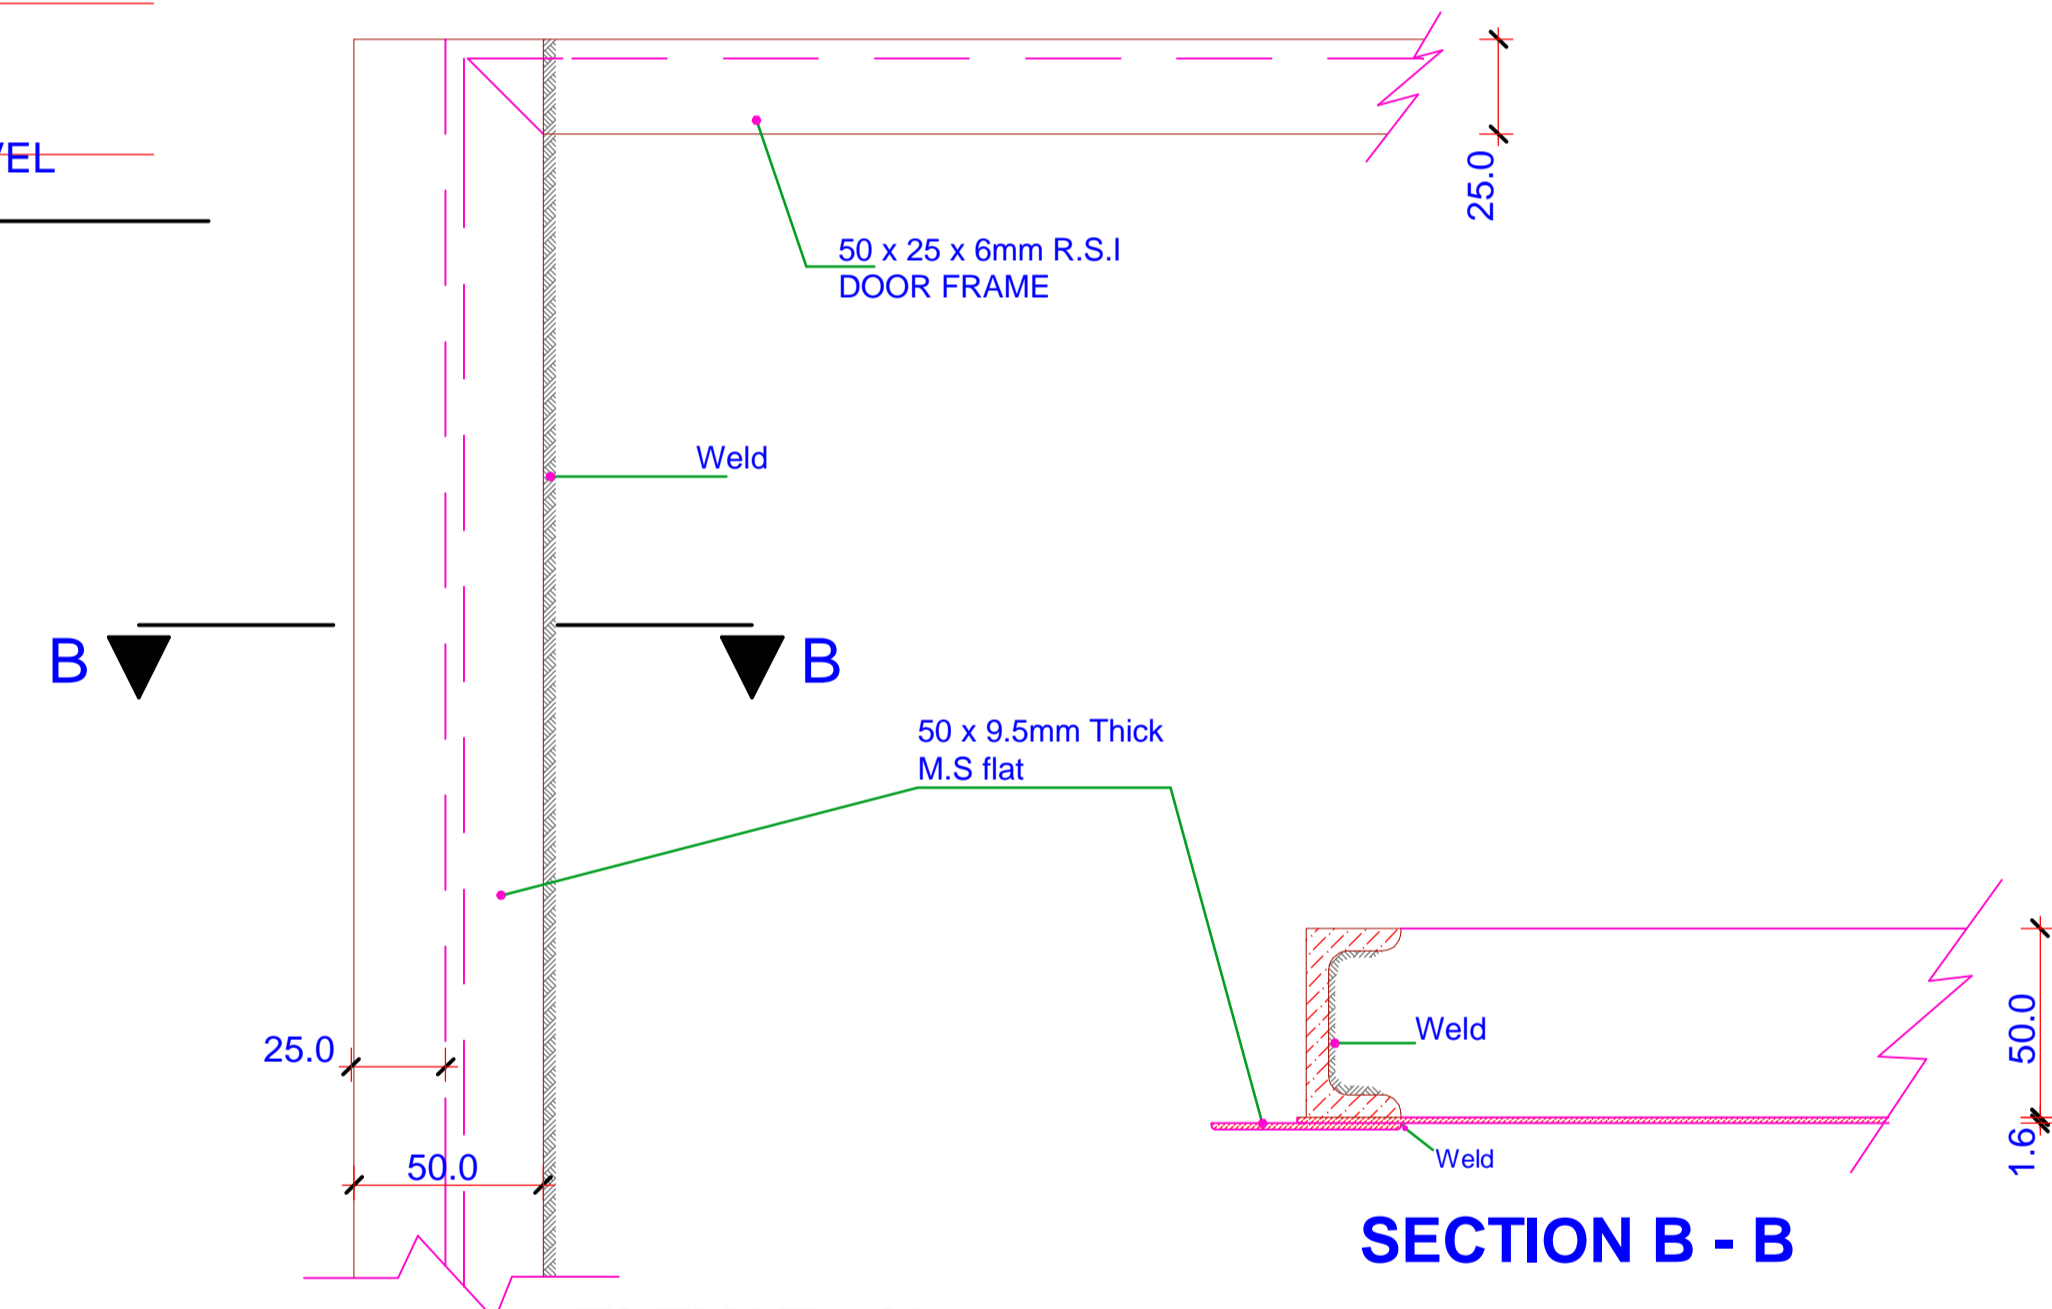

DETAIL 5. RIGHT HAND SIDE DOOR
SCALE : 1 : 2

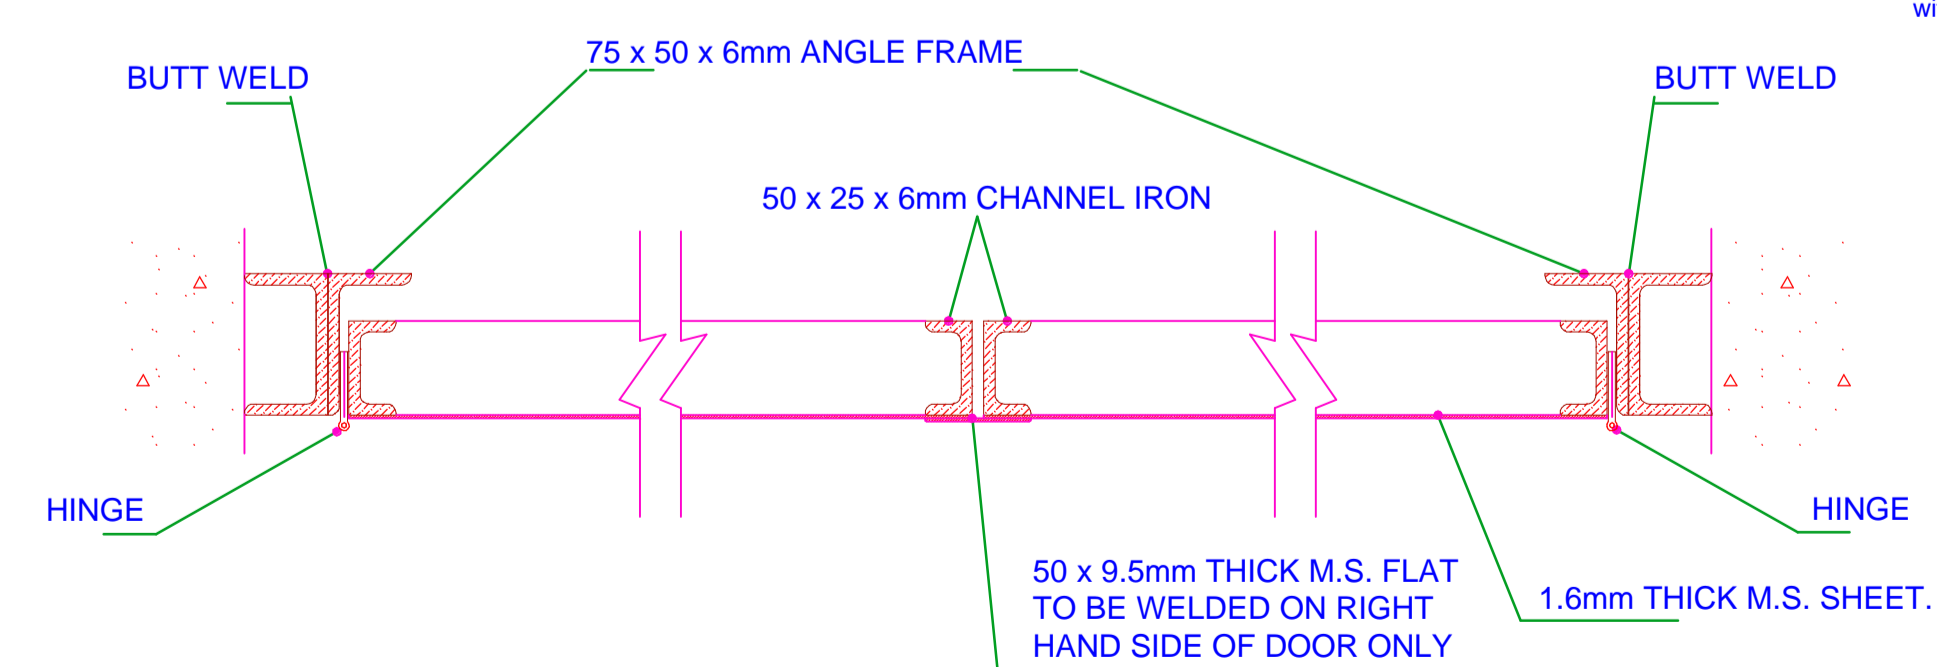

SECTION A - A
SCALE : 1 : 4

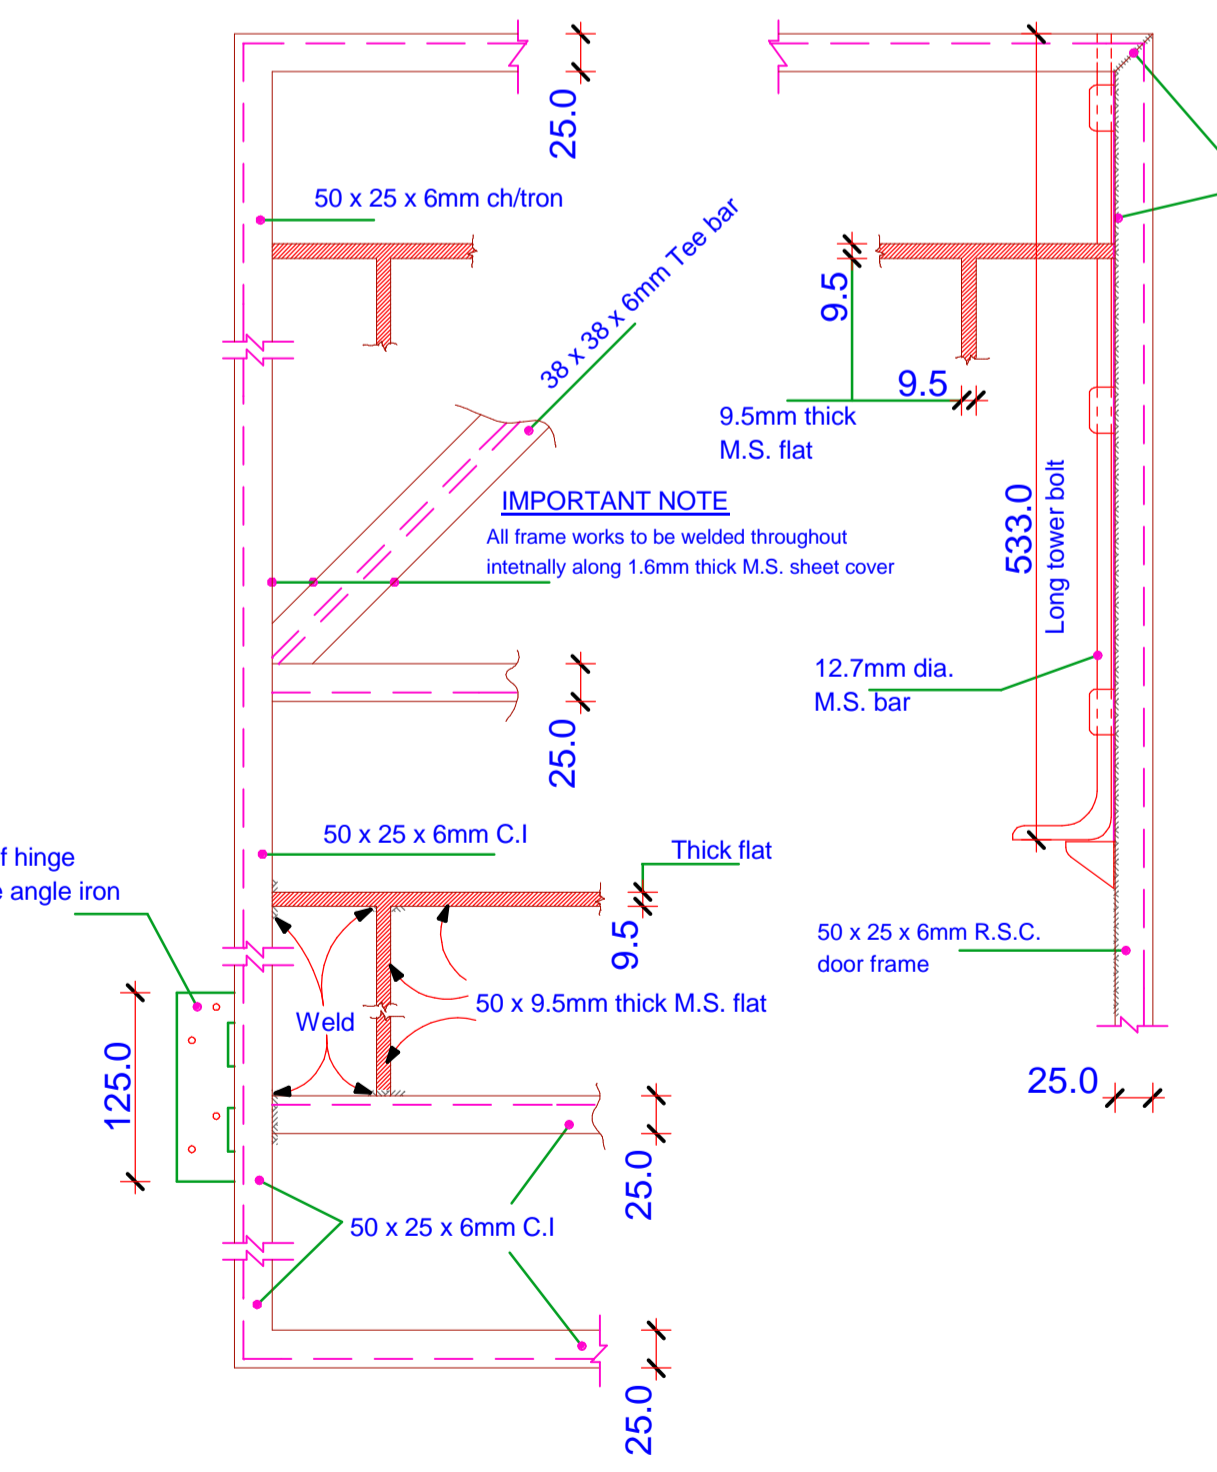

DETAILS 2,3,4 & 8 LEFT HAND SIDE DOOR
SCALE : 1 : 5

ITEM	DESCRIPTION	QTY	SIZE	REMARKS
1	DOOR FRAME	3 Pcs	75 x 50 x 6mm	Length as Rqd.
2	DOOR FRAME	6 Pcs	50 x 25 x 6mm	Length as Rqd.
3	BRACING T/ BAR	2 Pcs	38 x 38 x 6mm	Length as Rqd.
4	M.S. FLATS	12 Pcs	50 x 9.5mm	Length as Rqd.
5	M.S. FLATS (STOPPER)	1 Pcs	50 x 9.5mm	Length as Rqd.
6	HANDLES	2 Pcs	12.7mm Dia. M.S. Rod	Length as Rqd.
7	LOUVERS M.S.	28 Pcs	100 x 1.6mm	Length as Rqd.
8	TOWER BOLT	2 Pcs	533 x 12.7mm	Length as Rqd.
9	DOOR FRAME (CHANNEL)	3 Pcs	75 x 38 x 6mm	Length as Rqd.

APPROVED	DATE	SIGN	REF	REVISION	DATE	SIGN	CHECKED	DATE
CHECKED ENGINEER I/C								
CHECKED HEAD D/MAN								
CHECKED H/SURVEYOR								
DRAWN	J.M. Kahare	09/01/2002						
SURVEYED								
TRACED								

TYPICAL STEEL DOOR FOR SUBSTATION (REF. DRG. No. NA (149))

MIN. SIZE - 2514.6mm HEIGHT x 1930.4mm WIDTH

SCALE : AS SHOWN